Mainline Plan and Profile





BUSCONNECTS DUBLIN CORE BUS CORRIDORS INFRASTRUCTURE WORKS

TALLAGHT/CLONDALKIN TO CITY CENTRE CORE BUS CORRIDOR SCHEME

MAIN LINE PLAN AND PROFILE

DRAWING SERIES NUMBER(S)

BCIDA-ACM-GEO IX-0809 XX 00-DR-CR-0003

BCIDA-ACM-GEO_KP-0809_ML_00-DR-CR-0001

BCIDA-ACM-GEO_HV-0809_ML_00-DR-CR-0001 to 0045

DRAWING SERIES DESCRIPTION

TALLAGHT/CLONDALKIN TO CITY CENTRE CORE BUS CORRIDOR SCHEME. MAIN LINE PLAN AND PROFILE. COVER SHEET

TALLAGHT/CLONDALKIN TO CITY CENTRE CORE BUS CORRIDOR SCHEME. MAIN LINE PLAN AND PROFILE. KEY PLAN

TALLAGHT/CLONDALKIN TO CITY CENTRE CORE BUS CORRIDOR SCHEME. PLAN AND PROFILE

© National Transport Authority (NTA) 2023. This drawing is confidential and the copyright in it is owned by NTA. This drawing must not be either loaned, copied or otherwise the prior permission of NTA.

reproduced in whole or in part or used for any purpose without This drawing is to be used for the design element identified in the titlebox. Other information shown is to be considered indicative only. The drawing is to be read in conjunction with all other relevant design drawings. O.S. data used for plans are printed under © Ordnance Survey Ireland Government of Ireland. All rights reserved. Licence Number 2023/OSi_NMA_180 National Transport Authority. All elevations are in metres and relate to OSi Geoid Model (OSGM15) Malin Head. All Co-ordinates are in Irish

Transverse Mercator Grid (ITM) as defined by OSi active local e. GPS station. d Information concerning the position of apparatus shown on this drawing is based on drawings supplied by the utility owners and/or the utility works contractor, whilst every care has been taken in the preparation of this drawing, positions should be taken as approximate and are intended for general guidance only and no representation is made by the NTA as to the accuracy, completeness, sufficiency or otherwise of this drawing and the position of the apparatus. The information contained herein does not purport to be comprehensive or final as the apparatus is subject to being altered and/or superceded.

Recipients should not rely on this information. Any liabilities

The information contained herein has been provided by the NTA but does not purport to be comprehensive or final. Recipients should not rely on the information. Neither the NTA nor any of its directors, officers, employees, agents. stakeholders or advisers make any representation or warranty as to, or accept any liability or responsibility in relation to, the adequacy, accuracy, reasonableness or completeness of the information provided as part of this document or any matter on which the information is based (including but not limited to loss or damage arising as a result of reliance by recipients on the information or any part of it). Any liabilities are hereby



Drn Chk'd App'd M01 21/03/23 EM AD CA ISSUE FOR PHASE 4: PLANNING

Údarás Náisiúnta Iompair National Transport Authority

21/03/23

Project Code

Engineering Designer **AECOM**

A.DUGGAN

MACDONALD

Approved

BUSCONNECTS DUBLIN CORE BUS CORRIDORS INFRASTRUCTURE WORKS


TALLAGHT/CLONDALKIN TO CITY CENTRE CORE BUS CORRIDOR SCHEME MAIN LINE PLAN AND PROFILE **COVER SHEET**


Sheet Number Status 01 of 01 A BCIDA-ACM-GEO IX-0809 XX 00-DR-CR-0003


N/A @ A3 E.MINCHER


Scale _{N/A} @ A1 Drawn

Originator Code

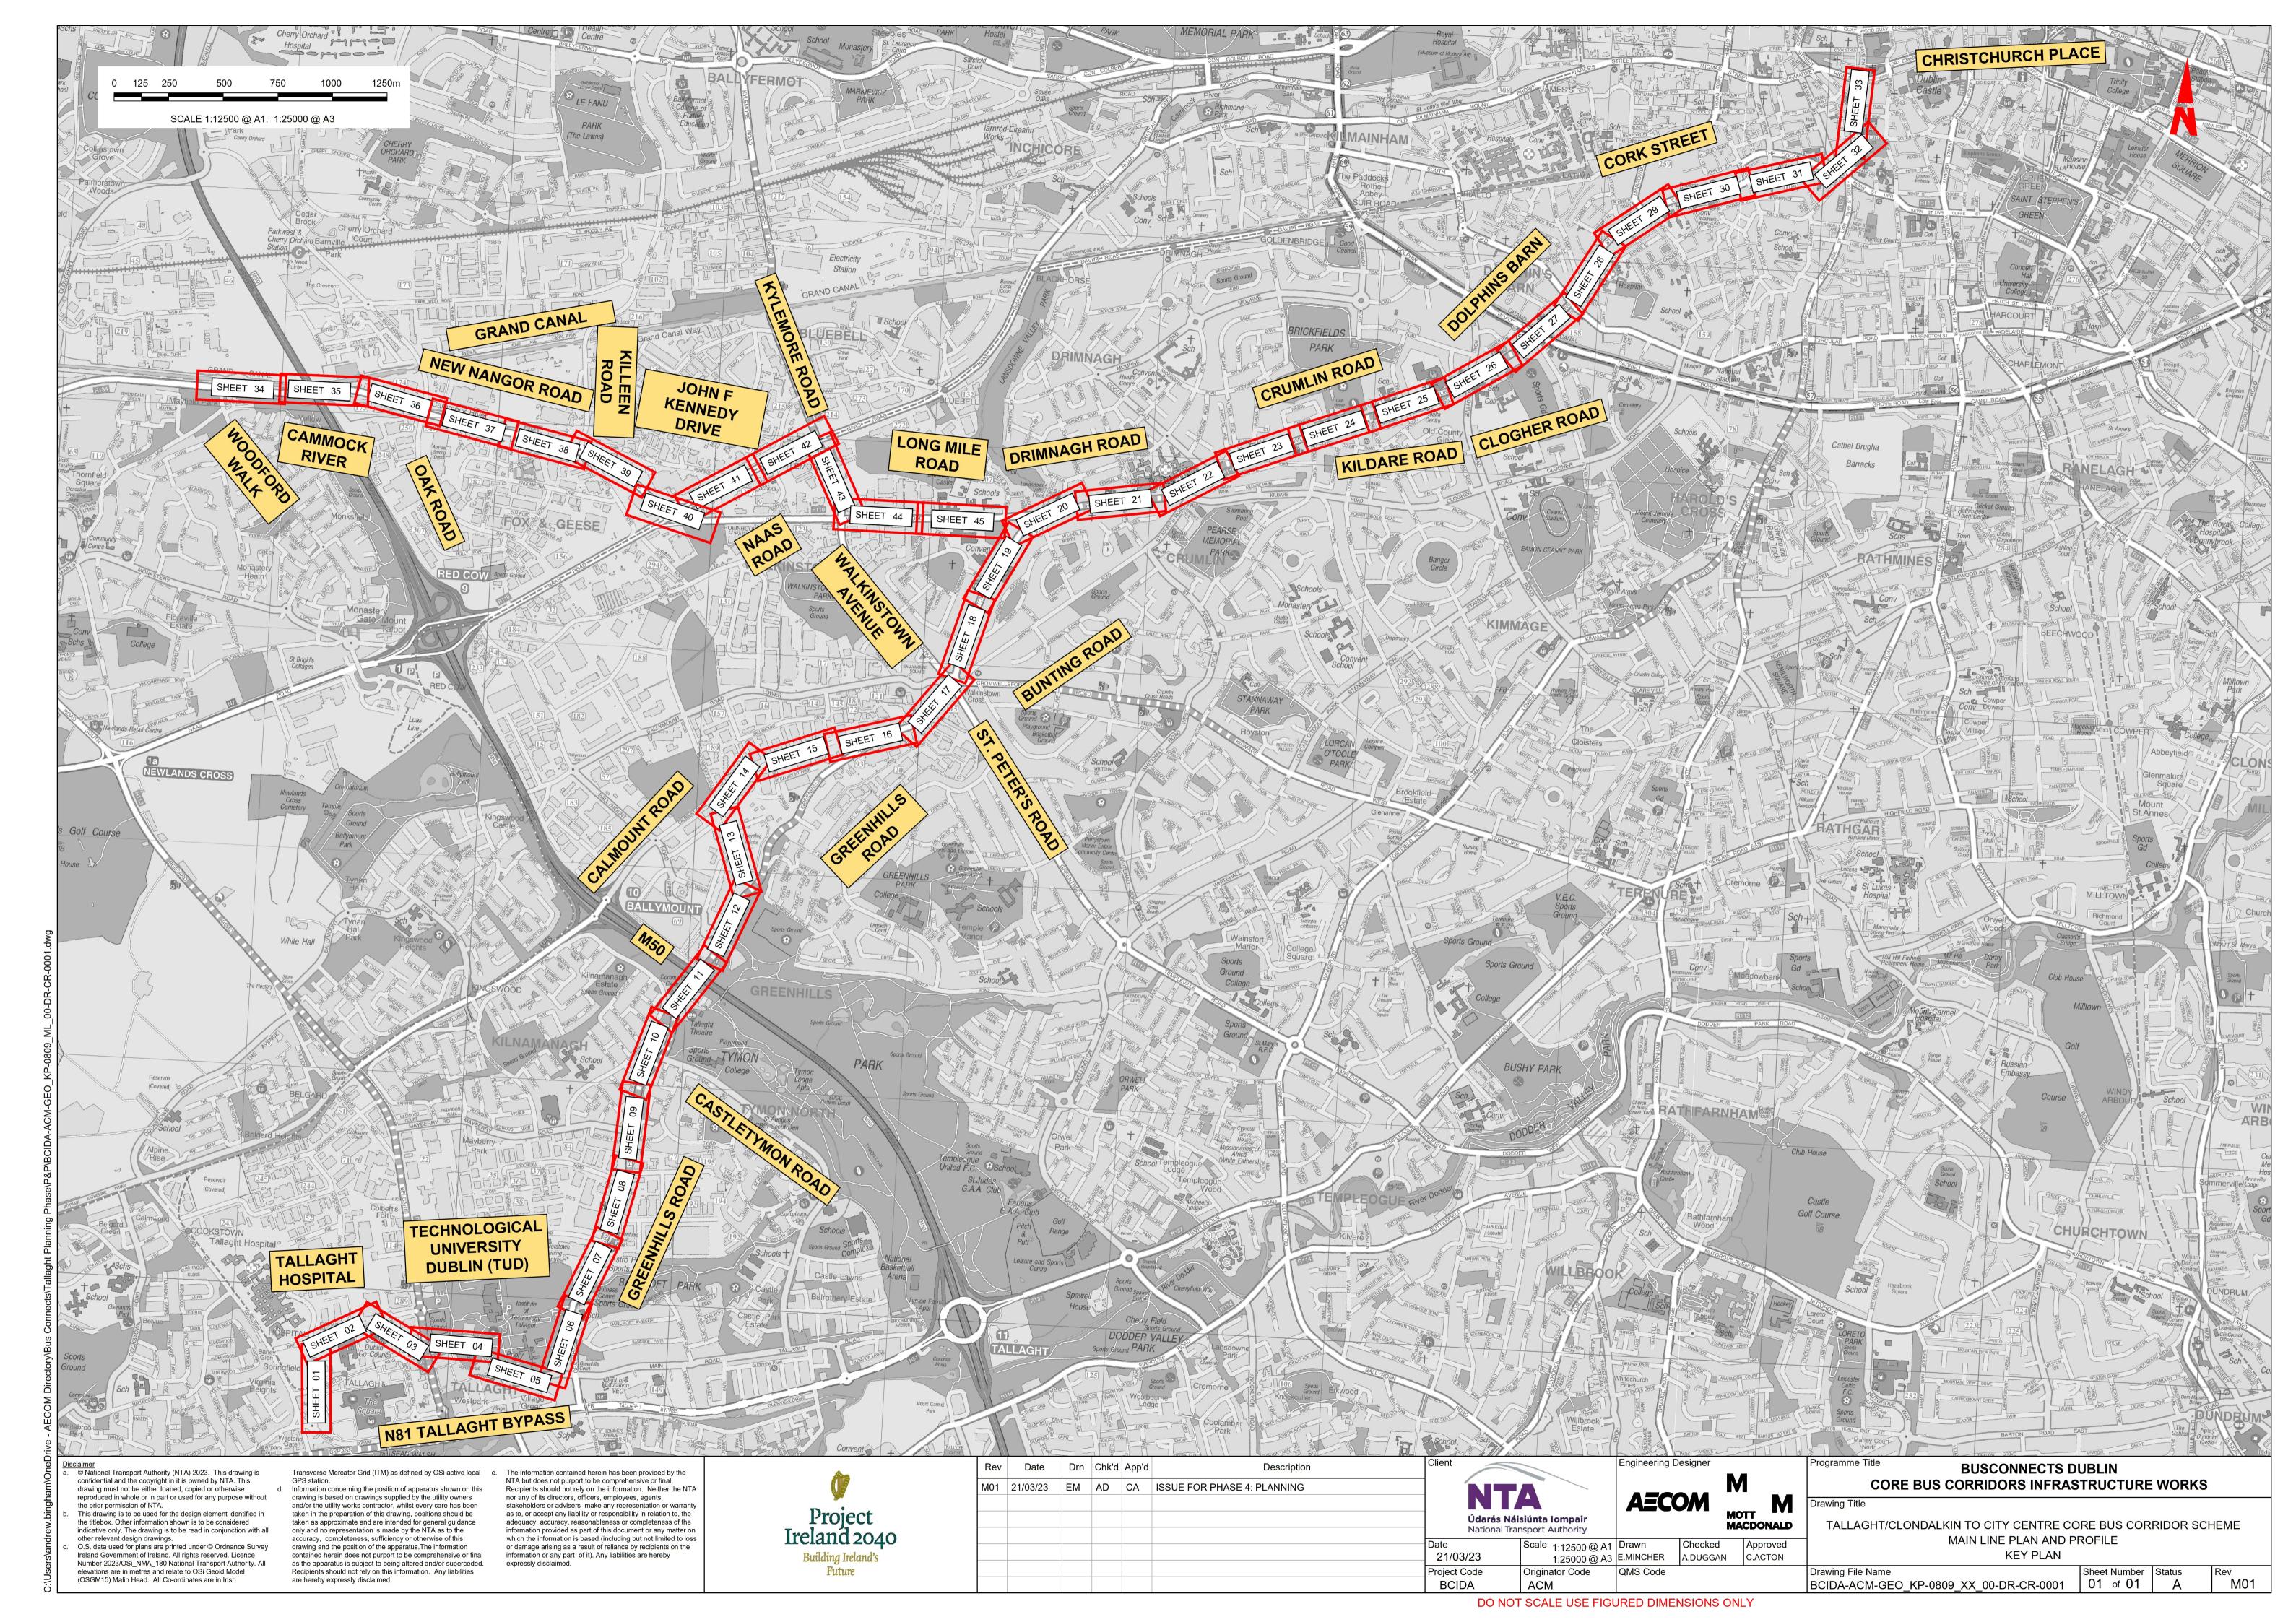

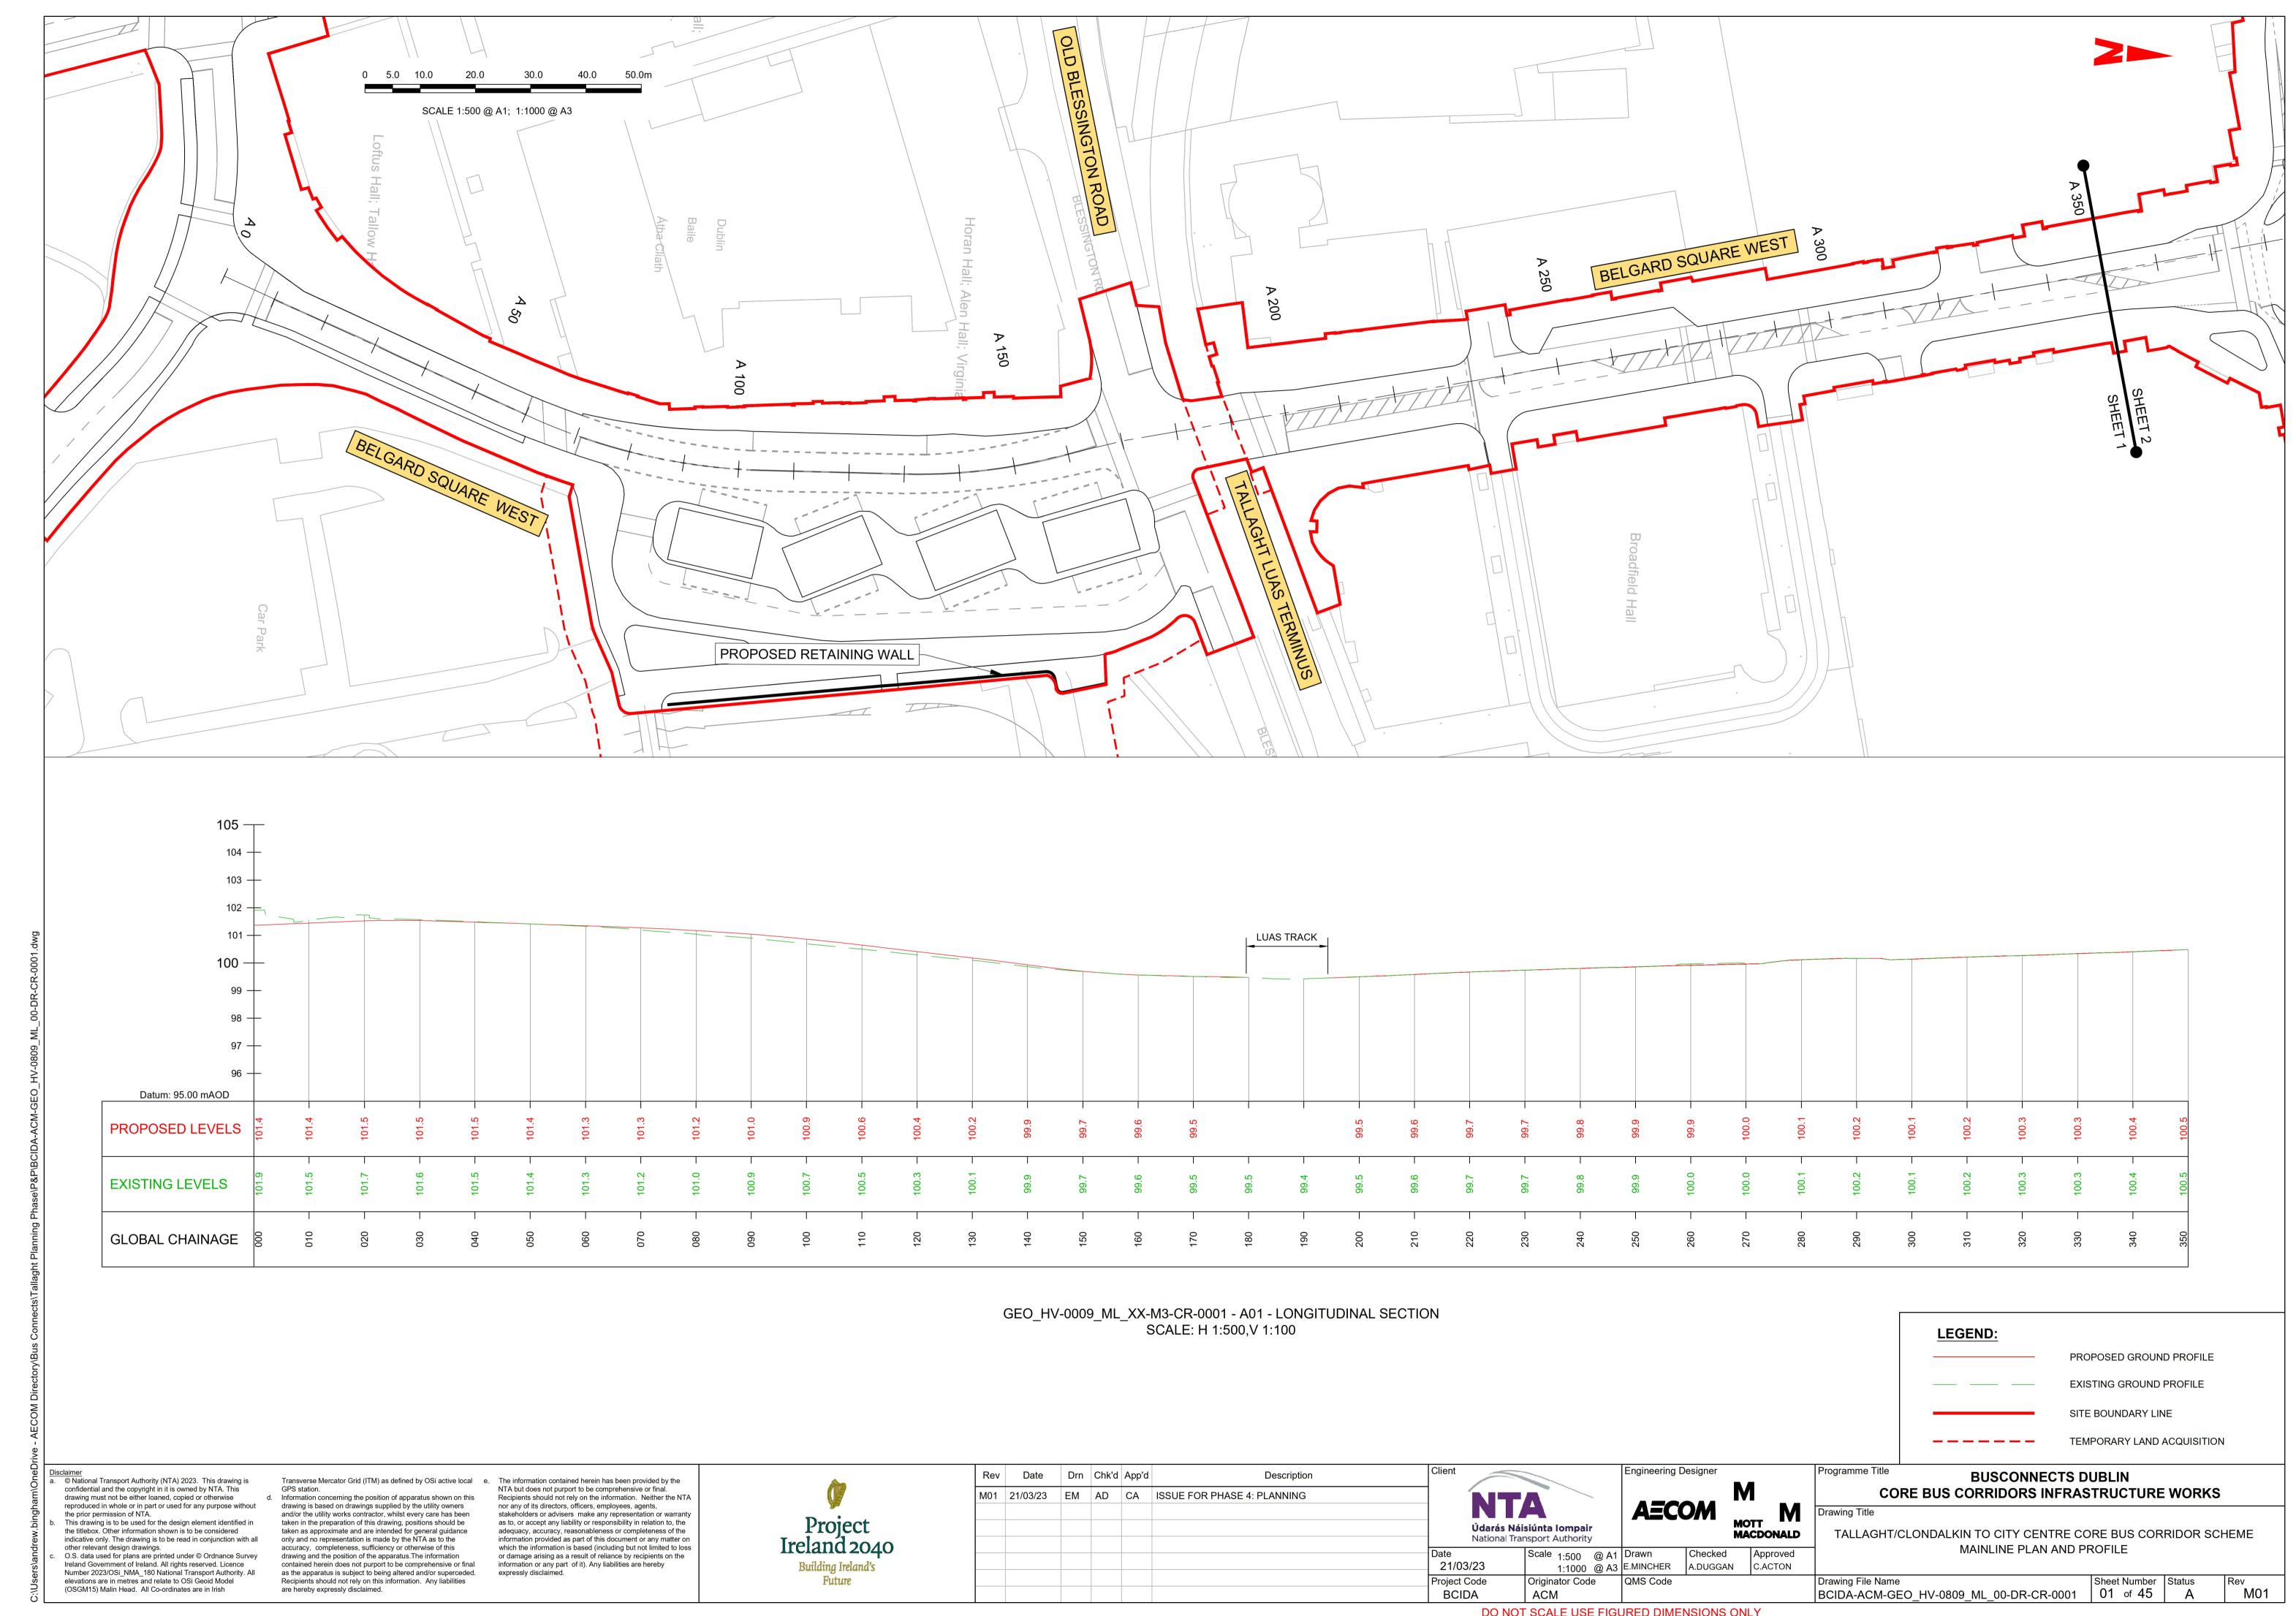

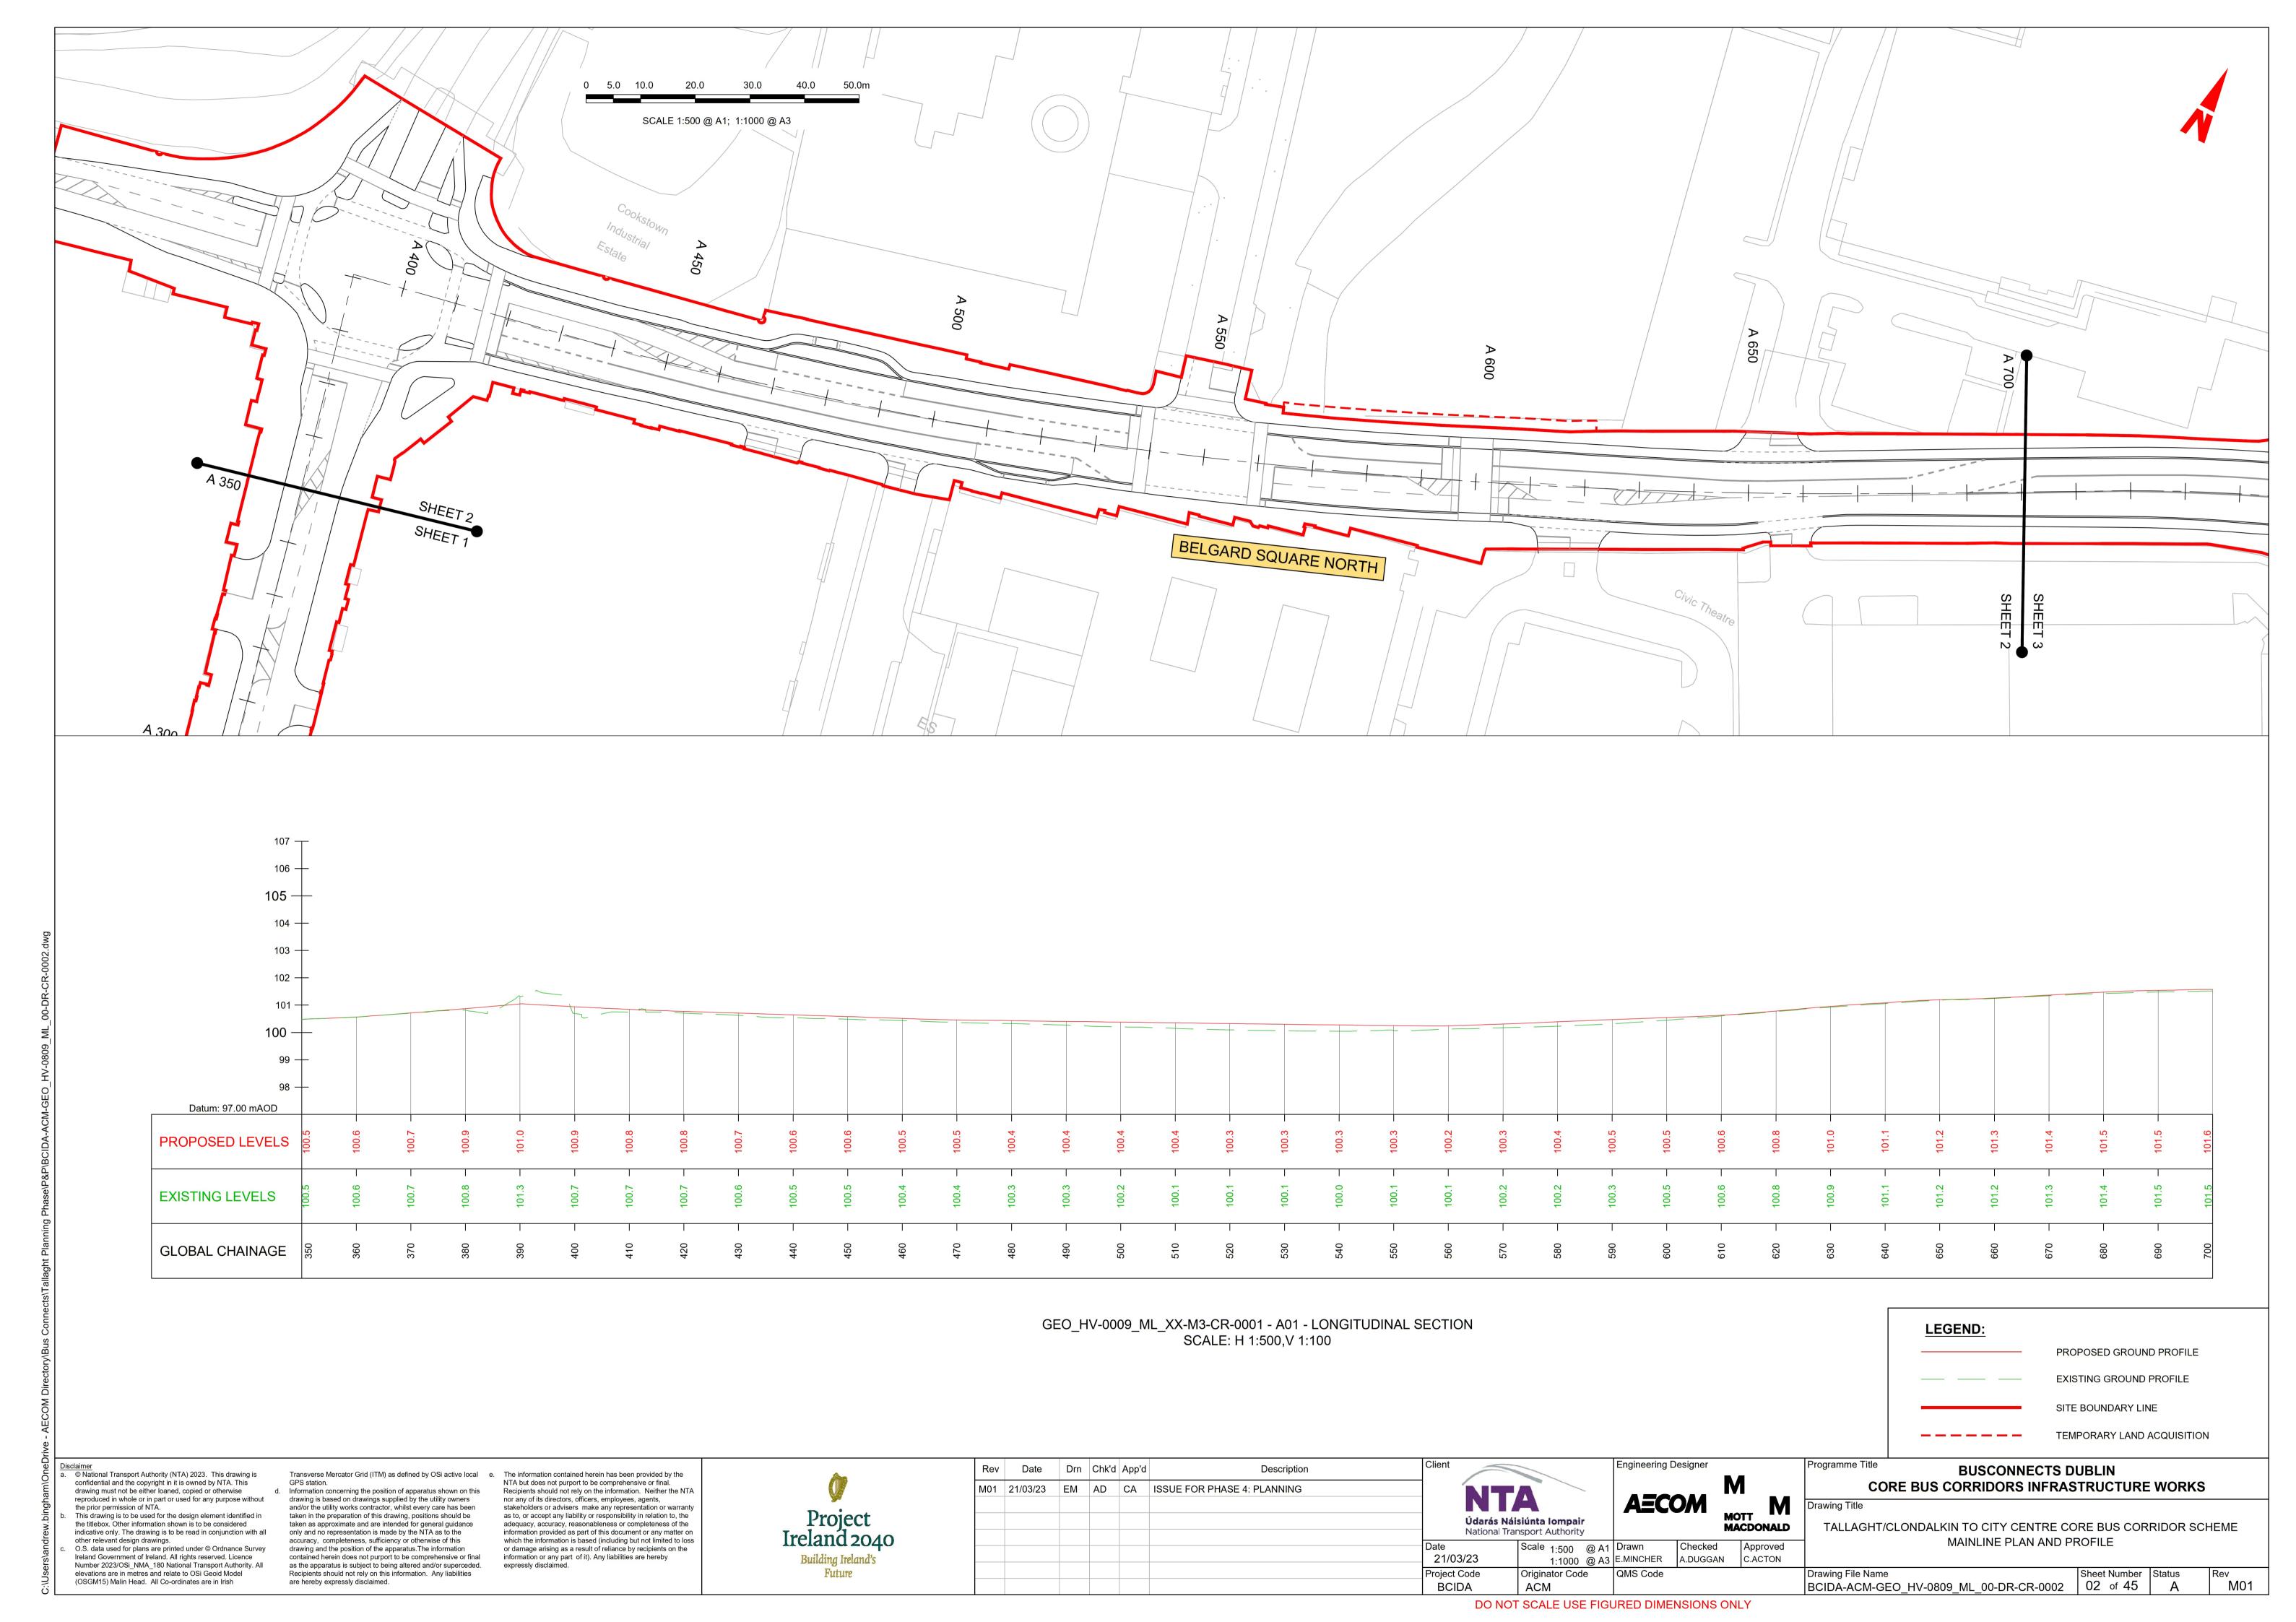

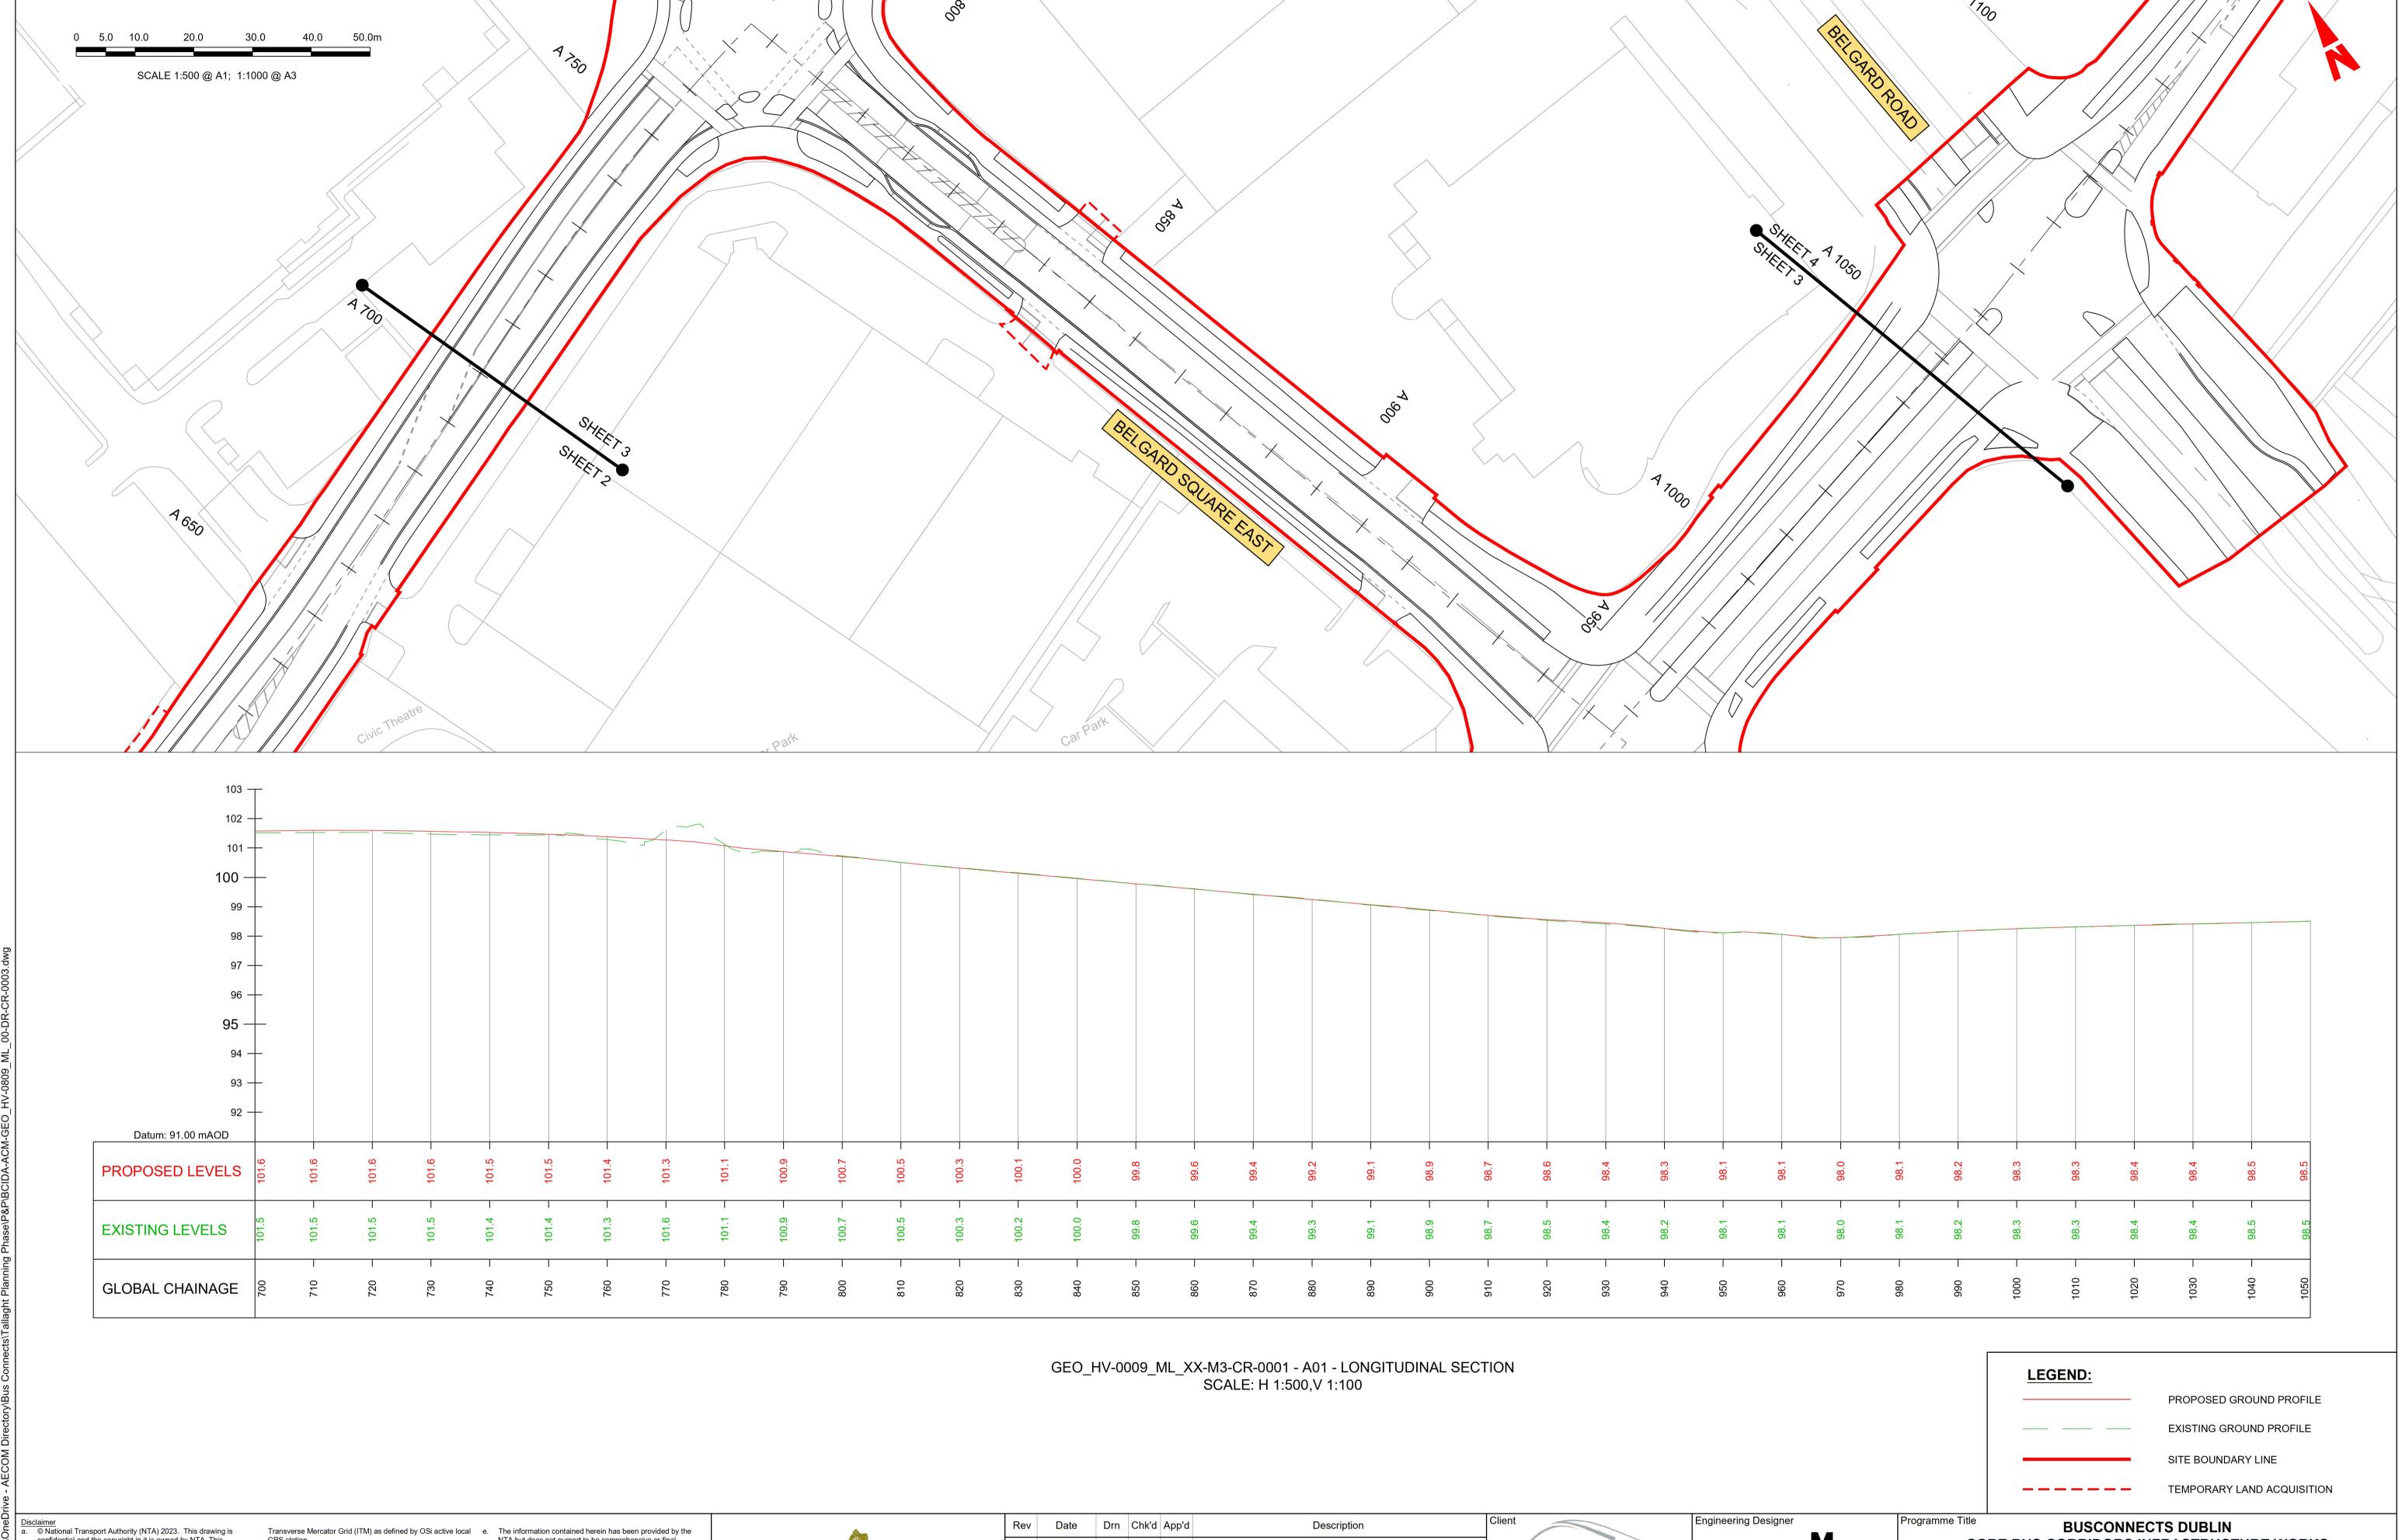

confidential and the copyright in it is owned by NTA. This drawing must not be either loaned, copied or otherwise reproduced in whole or in part or used for any purpose without the prior permission of NTA. This drawing is to be used for the design element identified in the titlebox. Other information shown is to be considered indicative only. The drawing is to be read in conjunction with all other relevant design drawings.

and/or the utility works contractor, whilst every care has been taken in the preparation of this drawing, positions should be taken as approximate and are intended for general guidance only and no representation is made by the NTA as to the accuracy, completeness, sufficiency or otherwise of this O.S. data used for plans are printed under © Ordnance Survey drawing and the position of the apparatus. The information Ireland Government of Ireland. All rights reserved. Licence Number 2023/OSi_NMA_180 National Transport Authority. All contained herein does not purport to be comprehensive or final as the apparatus is subject to being altered and/or superceded. elevations are in metres and relate to OSi Geoid Model (OSGM15) Malin Head. All Co-ordinates are in Irish Recipients should not rely on this information. Any liabilities

GPS station. d. Information concerning the position of apparatus shown on this drawing is based on drawings supplied by the utility owners

are hereby expressly disclaimed.

NTA but does not purport to be comprehensive or final. Recipients should not rely on the information. Neither the NTA nor any of its directors, officers, employees, agents, stakeholders or advisers make any representation or warranty as to, or accept any liability or responsibility in relation to, the adequacy, accuracy, reasonableness or completeness of the information provided as part of this document or any matter on which the information is based (including but not limited to loss or damage arising as a result of reliance by recipients on the information or any part of it). Any liabilities are hereby expressly disclaimed.

Project Ireland 2040
11elallu 2040
Building Ireland's
Future

	Becompain	a , , , pp a	O i iii C	J	Date	1101
	ISSUE FOR PHASE 4: PLANNING	CA	AD	EM	21/03/23	M01
Data						
Date 21/03						
Project C						
			1	1	I .	

Údarás Náisiúnta Iompair National Transport Authority Scale 1:500 @ A1 Drawn

Originator Code

AECOM

A.DUGGAN

Checked Approved

MOTT MACDONALD

C.ACTON

Drawing File Name

CORE BUS CORRIDORS INFRASTRUCTURE WORKS

BCIDA-ACM-GEO_HV-0809_ML_00-DR-CR-0003 03 of 45

TALLAGHT/CLONDALKIN TO CITY CENTRE CORE BUS CORRIDOR SCHEME MAINLINE PLAN AND PROFILE

Sheet Number Status

M01

BCIDA ACM DO NOT SCALE USE FIGURED DIMENSIONS ONLY

1:1000 @ A3 E.MINCHER

QMS Code

